

REVISIONS

1	PERMIT COMMENTS 05.07.10
2	OFFICE PLAN REVISED 06.01.10
3	PERMIT COMMENTS 06.30.10
4	PERMIT COMMENTS 07.28.10
5	CONST. SET, N LOBBY ALT. 11.05.10

DATE

05.05.10

BCRANO


09430

CADD FILE

09430A5.02.dwg

SHEET TITLE

OFFICES REFLECTED
 CEILING PLAN

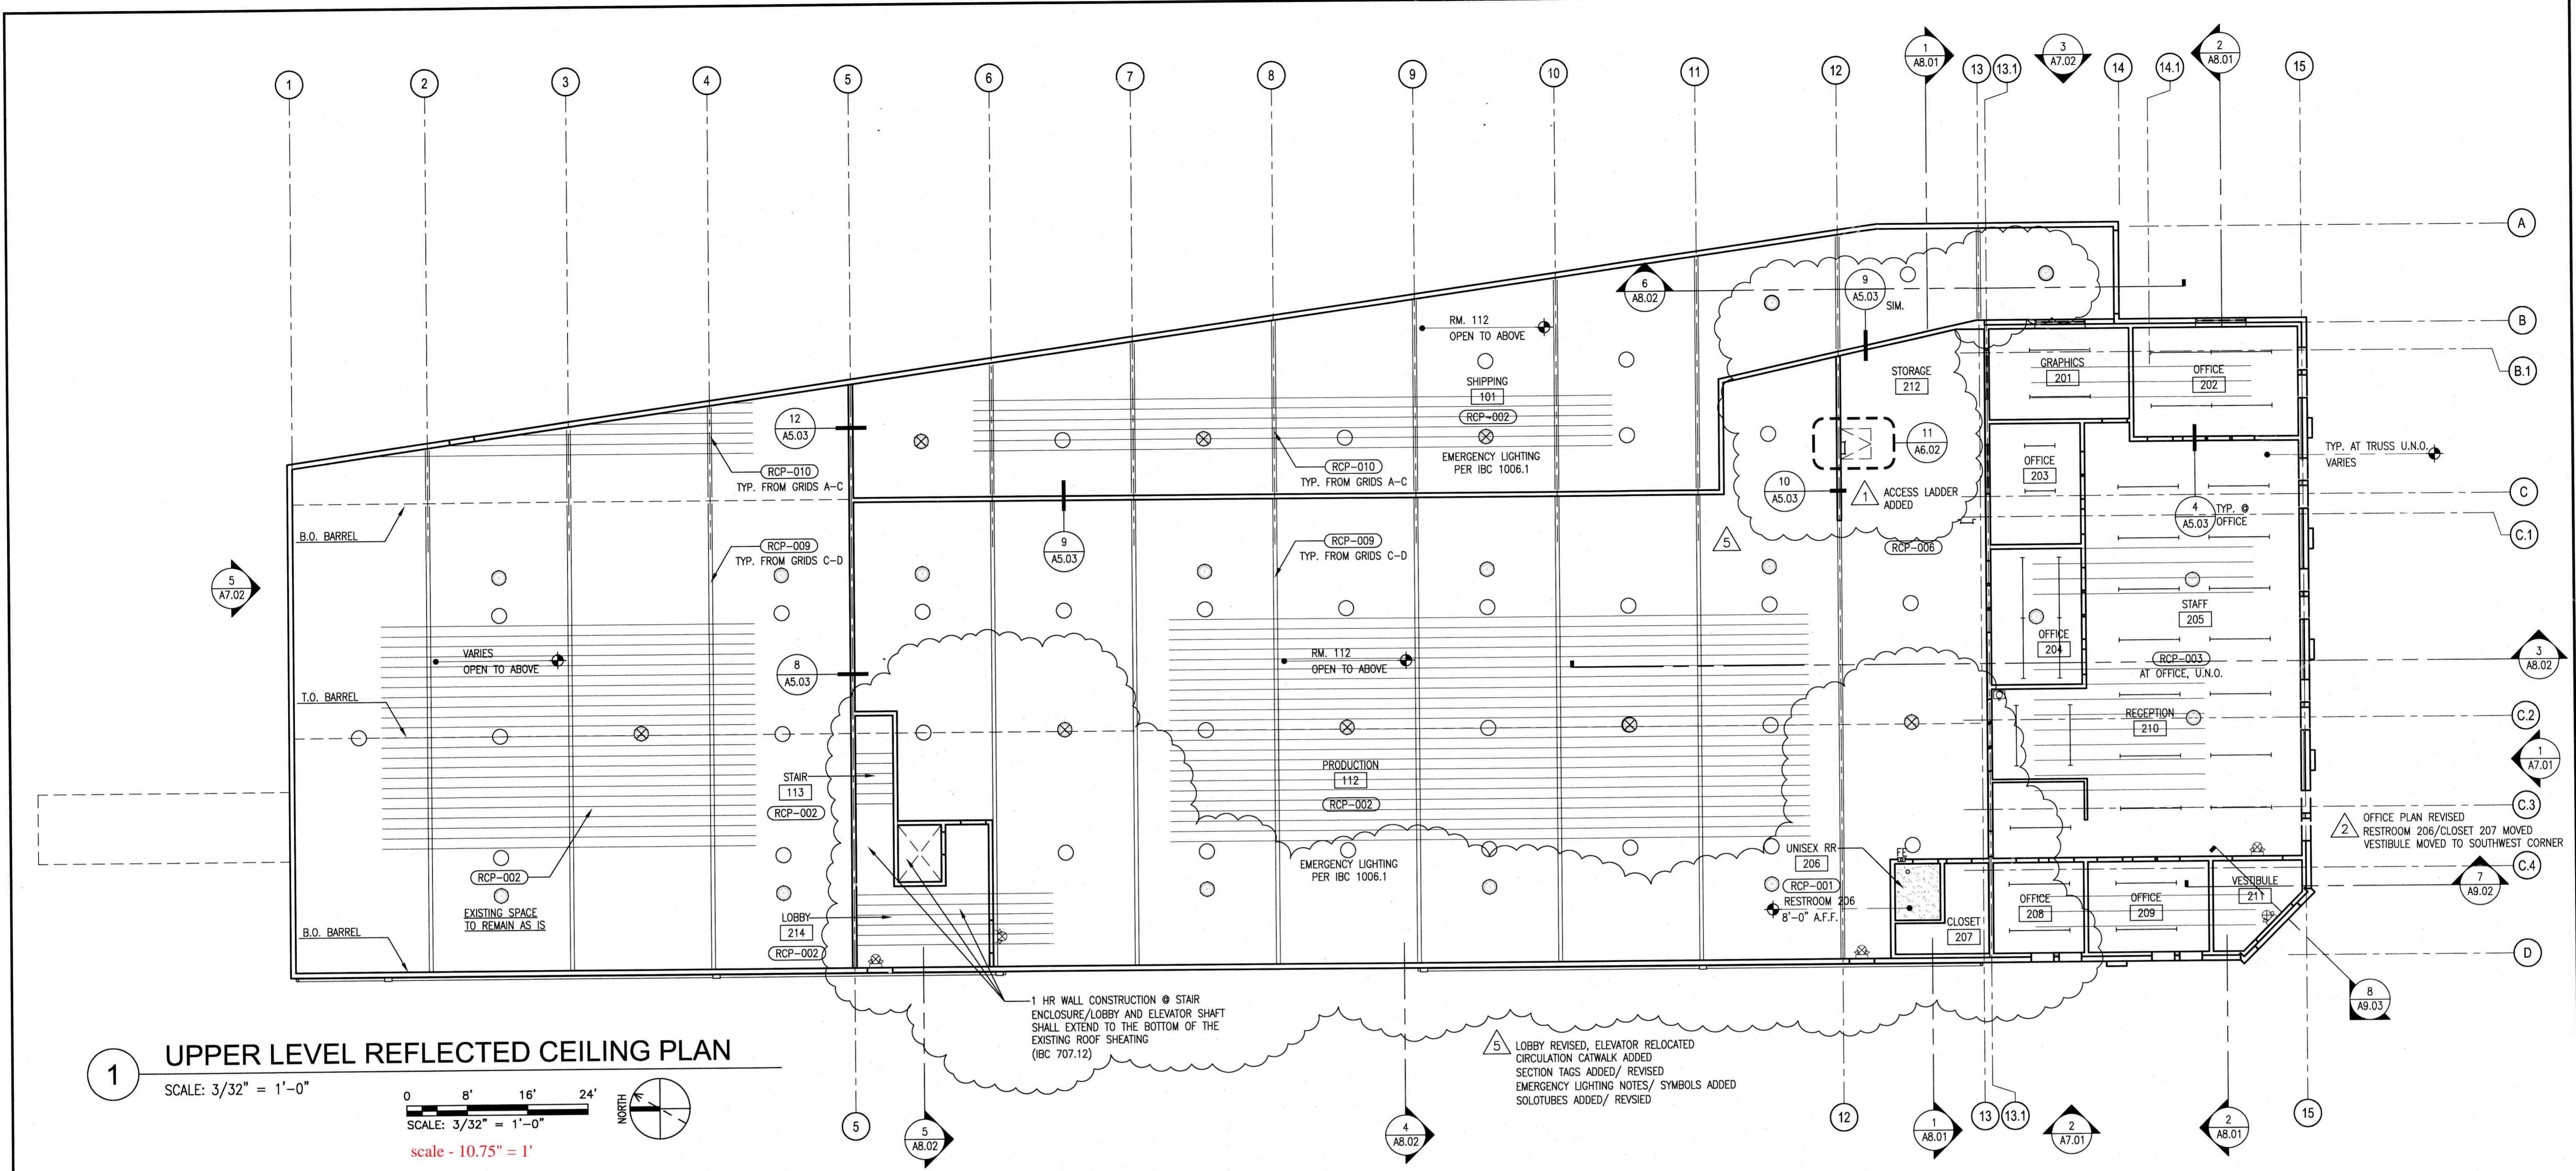

1 UPPER LEVEL REFLECTED CEILING PLAN
 SCALE: 3/32" = 1'-0"
 0 8' 16' 24'
 SCALE: 3/32" = 1'-0"
 scale - 10.75" = 1'

REFLECTED CEILING PLAN GENERAL NOTES:

- ALL LIGHTING IS SHOWN FOR COORDINATION PURPOSES ONLY. REFER TO ELECTRICAL FOR LIGHTING LAYOUT AND LIGHT FIXTURE SPECIFICATIONS.
- SEE ROOM FINISH SCHEDULE FOR CEILING FINISHES.
- SEE SECTIONS FOR VARIED CEILING HEIGHTS.
- ALL EXPOSED DUCT, CONDUIT, PIPE, ETC IS TO BE COORDINATED W/ OWNER FOR FINISH.
- ALL MECHANICAL, ELECTRICAL, PLUMBING AND SPECIFICATION DRAWINGS FOR LOCATIONS OF EXPOSED DUCTS, FINISH CEILING HEIGHTS ARE MEASURED FROM THE FINISH FLOOR.
- PROVIDE CEILING ACCESS PANELS TO ALL PLUMBING VALVES, WHERE APPLICABLE.
- COORDINATE W/ DEFERRED SUBMITTAL DESIGNS (MECHANICAL, PLUMBING, ELECTRICAL, FIRE SPRINKLER/SMOKE ALARM, ETC.)
- EMERGENCY/EGRESS LIGHTING PER IBC 1006
- STANDARD LIGHTING PER IBC 1205

REFLECTED CEILING PLAN KEYNOTES:

RCP-001	GWB
RCP-002	OPEN TO EXIST. STRUCTURE ABOVE - HEIGHT VARIES
RCP-003	OPEN TO NEW I-JOIST ROOF ABOVE - HEIGHT VARIES
RCP-004	
RCP-005	
RCP-006	ROOF ACCESS LADDER W/ 36"x66" ROOF ACCESS HATCH (MIN. 16 SF)
RCP-007	18"x18" MINIMUM ACCESS HATCH- VERIFY SIZE WITH SPRINKLER CONTRACTOR, COORDINATE LOCATION WITH ARCHITECT IN FIELD.
RCP-008	
RCP-009	EXISTING BOWSTRING TRUSS
RCP-010	EXISTING GLU-LAM BEAM

REFLECTED CEILING PLAN LEGEND

	GWB, SEE FINISH SCHEDULE FOR FINISH
	OPEN TO EXIST. ROOF FRAMING: 2x12 AT 16" O.C. (GRIDS 1-13)
	OPEN TO NEW ROOF FRAMING: 34" RED-L ROOF JOISTS @ 24" O.C. (GRIDS 13-15 @ OFFICE)

LEGEND

	SURFACE OR PENDANT MOUNT STRIP LIGHT
	SURFACE OR PENDANT MOUNT FLUORESCENT LIGHT FIXTURE
	RECESSED COMPACT FLUORESCENT CAN DOWNLIGHT, 6" DIAMETER
	PENDANT MOUNT LIGHT FIXTURE, 24" DIAMETER
	EXIT SIGN
	SOLATUBE DAYLIGHTING SYSTEM
	SOLATUBE DAYLIGHTING SYSTEM AT EXISTING LIGHT

Date Plotted: Oct 20, 2010 - 7:35am File Name: 09430-A5.02.dwg By: JHOFFMAN