
SHEET INDEX			
SHEET NUMBER	SHEET TITLE		
C-1.0 1 OF 3	COVER SHEET		
C-1.1 2 OF 3	EXISTING CONDITIONS MAP		
C-1.2 3 OF 3	SITE & UTILITY PLAN		

## **LEGEND**

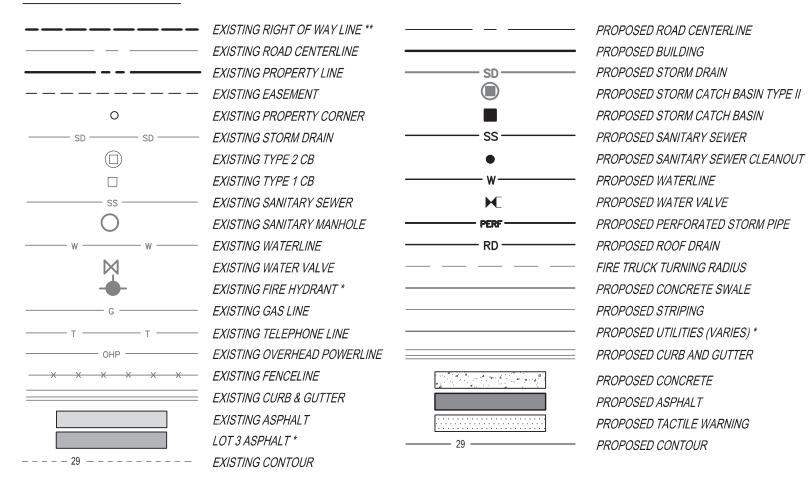

#### LEGAL DESCRIPTION

LOT 4 OF SOUTH MOUNT VERNON BUSINESS PARK BINDING SITE PLAN NO. LU05-061, AS APPROVED ON AUGUST 30,2007 AND RECORDED SEPTEMBER 10, 2007 UNDER AUDITORS FILE NO. 200709100133, RECORDS OF SKAGIT COUNTY, WASHINGTON.

#### SITE INFORMATION

SITE PARCEL NUMBER: P126617

328 EAST BLACKBURN RD. SITE ADDRESS: 35,720 SQ. FT. - 0.82 ACRES SITE AREA: SITE ZONING:

PROPOSED USE: WAREHOUSE / OFFICE

OCCUPANCY GROUP: B OCCUPANCY (BUSINESS), S2 OCCUPANCY (STORAGE WAREHOUSE)

BUILDING CODE: 2018-19 INTERNATIONAL BUILDING CODE

BUILDING SPECS: # OF UNITS: 5 UNITS SQUARE FOOTAGE: SEE ARCHITECTURAL PLANS BUILDING HEIGHT: 27 FT % LOT COVERED: 16.6% 18.4%

IMPERVIOUS SURFACE AREA: 24,093 SQ. FT. % IMPERVIOUS SURFACE: 67.45%

### UNDERGROUND FIRE LINE REQUIREMENTS:

- 1. THE ENTIRE UNDERGROUND FIRE LINE WILL REQUIRE A FULL HYDRO-TEST AT 200 PSI FOR TWO (2) HOURS. CONTACT THE FIRE MARSHAL BEFORE PERFORMING THIS TEST.
- 2. EACH FIRE HYDRANT AND FDC RISER ON THE FIRE SYSTEM WILL REQUIRE A ONE (1) MINUTE FLUSH FROM THE PUMPER PORT OR MANIFOLD WITH A DIFFUSER OR UNTIL THERE ARE NO PARTICULATES IN THE SYSTEM.
- 3. THE PUMPER PORT ON THE HYDRANTS SHALL HAVE A FIVE (5) INCH STORTZ HARD FACED COUPLER INSTALLED PRIOR TO FINAL APPROVAL.
- 4. A COPY OF NFPA U FORM FILLED OUT MUST BE PROVIDED TO THE FIRE MARSHAL PRIOR TO FINAL.
- 5. ALL FITTINGS AND PIPING FROM THE VAULT TO THE BUILDING WILL NEED TO BE INSPECTED BY THE FIRE MARSHAL PRIOR TO COVER.

7. ALL WORK BEING DONE FROM THE DOUBLE CHECK VALVE ASSEMBLY TO THE RISER WILL NEED TO BE INSTALLED BY A U LICENSED CONTRACTOR.

- 6. THREE (3) SETS OF PLANS, MATERIAL CUT SHEETS AND FIRE FLOW CALCULATIONS WILL NEED TO BE APPROVED PRIOR TO ANY WORK BEING DONE.
- AN UNDERGROUND FIRE MAIN PERMIT WILL BE REQUIRED FOR THIS PROJECT. NO WORK MAY COMMENCE ON THE SYSTEM OUTLINED IN THIS PLAN UNTIL THE PERMIT PLANS HAVE

BEEN REVIEWED, APPROVED, AND ALL FEES HAVE BEEN PAID. A SEPARATE IFC CONSTRUCTION PERMIT IS REQUIRED FOR THE INSTALLATION OF THE PORTION OF THE DEDICATED UNDERGROUND WATER SUPPLY PIPING, PUBLIC OR PRIVATE,

SUPPLYING A WATER-BASED FIRE PROTECTION SYSTEM.


EXCEPTION: WHEN THE UNDERGROUND PIPING IS INSTALLED BY THE ABOVEGROUND PIPING CONTRACTOR.

### **OWNER:**

LTK PROPERTIES, LLC P.O. BOX 117 MOUNT VERNON, WA 98273 PH: 360.424.3638

### **ENGINEER/SURVEYOR:**

SOUND DEVELOPMENT GROUP, LLC PAT SEVERIN / JAY STANDISH 1111 CLEVELAND AVENUE, SUITE 202 MOUNT VERNON, WA 98273 PH: 360.404.2010 EM: pat@sdg-llc.com / jay@sdg-llc.com

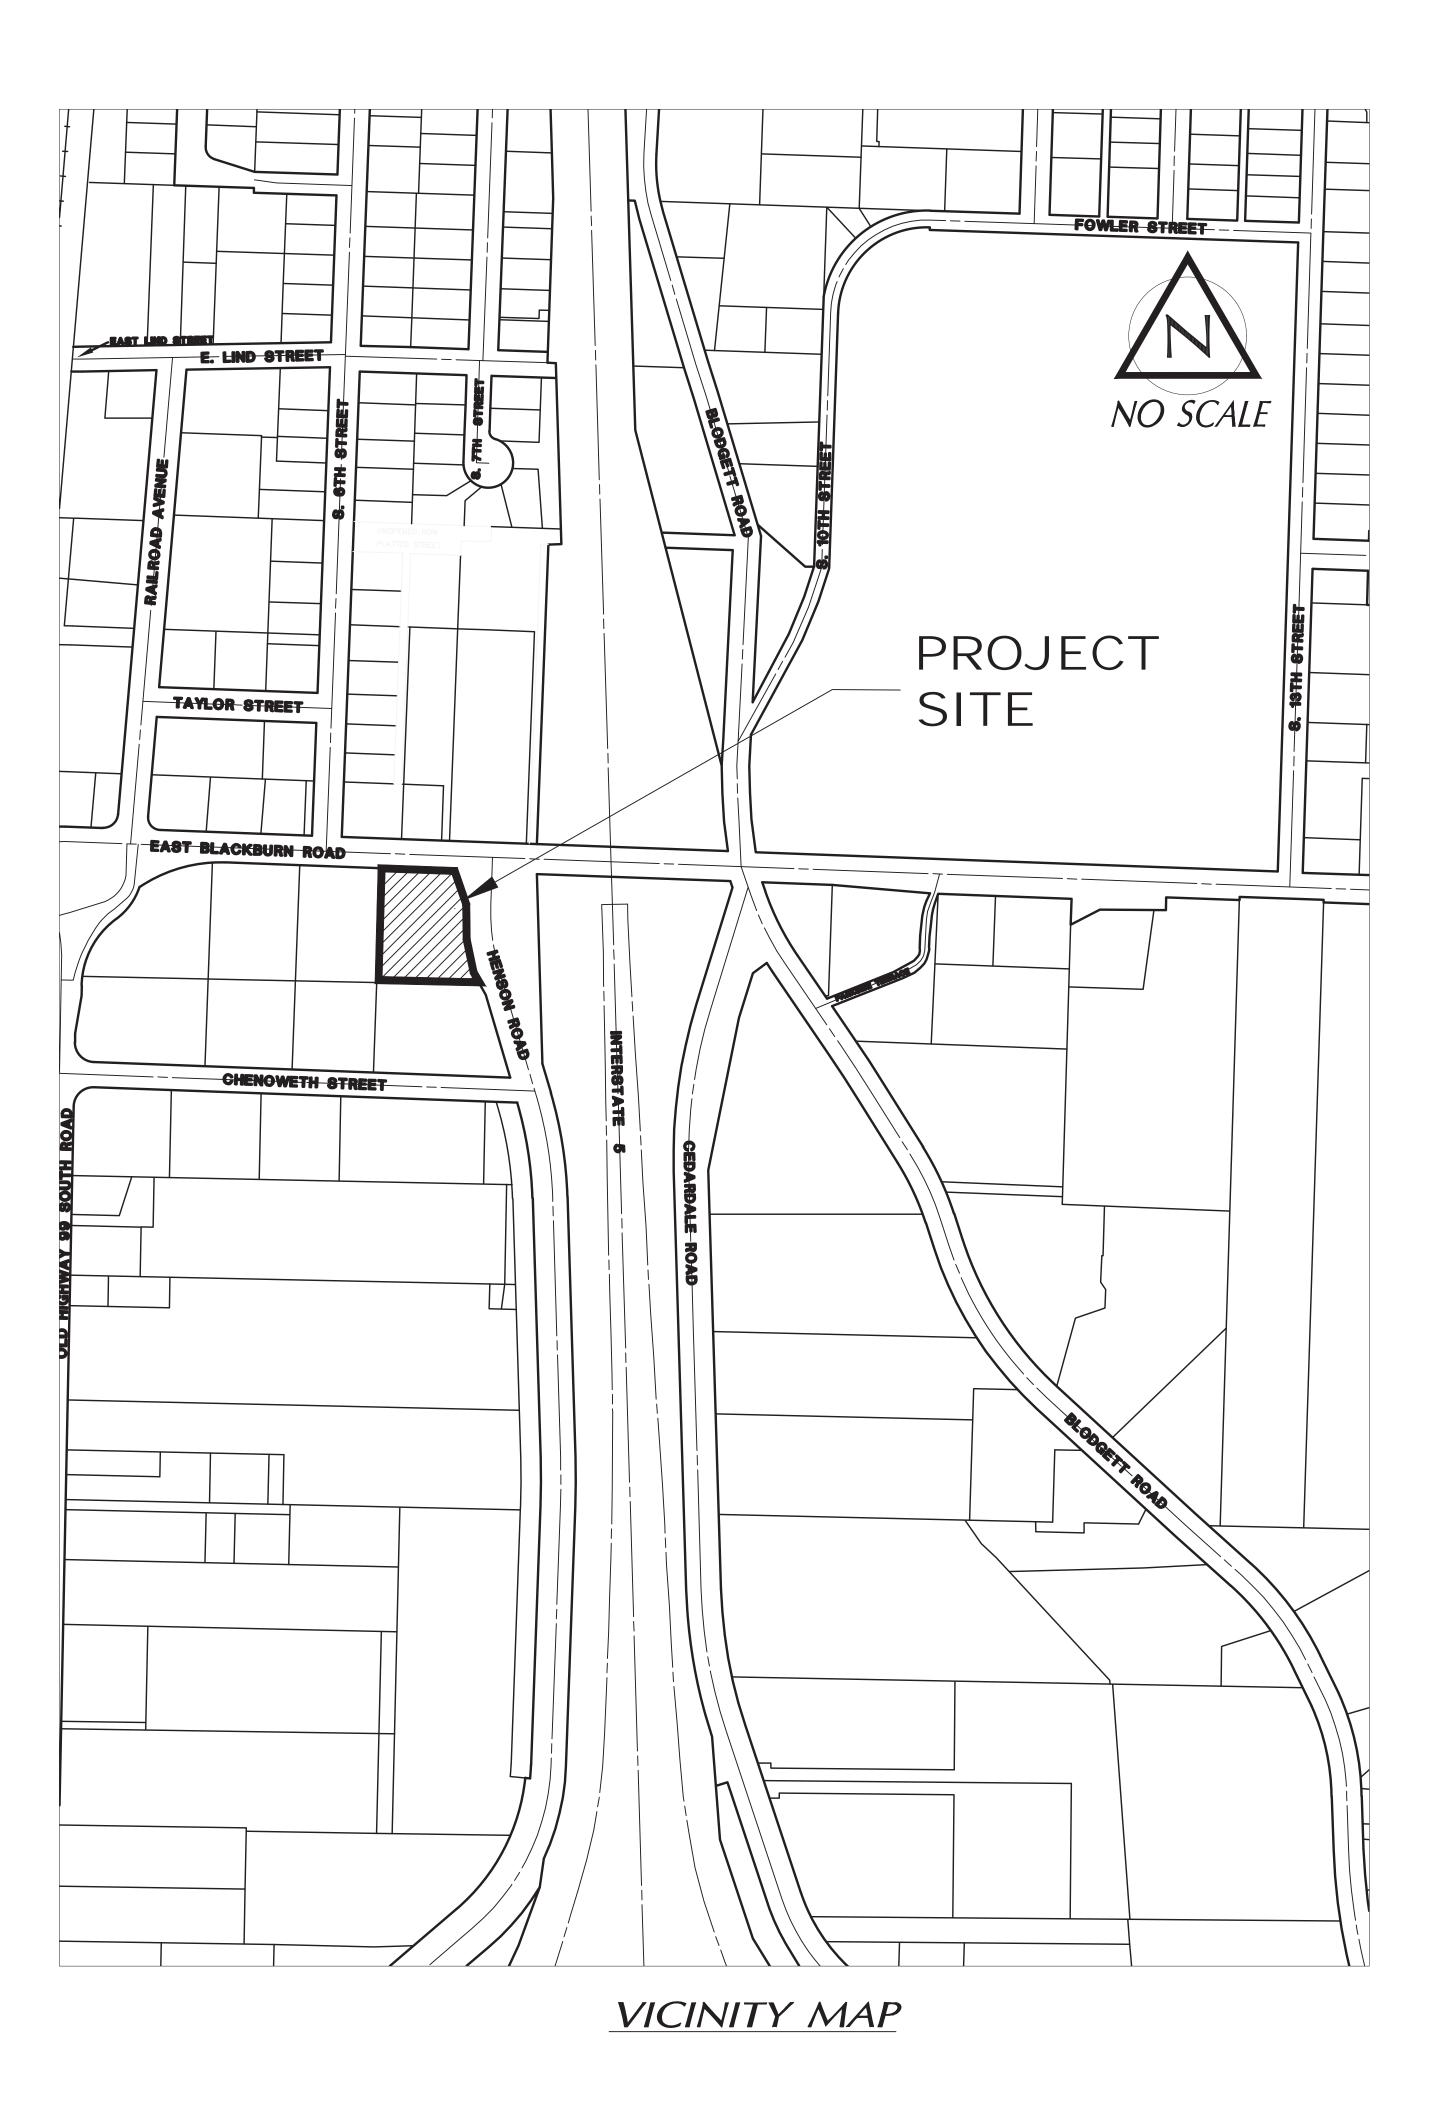


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NO. DATE DESCRIPTION
1 6.15.23 BUILDING B REVISION P.SEVERIN 2 6.20.24 SITE PLAN REVISION P.SEVERIN

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SCALE:	NO SCALE
DRAWN BY:	C.SEVERIN
DESIGNED BY:	P.SEVERIN
DATE:	12.22.2021
JOB NUMBER:	21028
DWG NAME:	21028ENG.DWG
SHEET NUMBER:	



\* IMPROVEMENT TO BE COMPLETED AS A PART OF SMVBP LOT 3 DEVELOPMENT PRIOR TO BUILDING OCCUPATION, SEE CMV FILE NO. PLAN21-0251
\*\* EXISTING RIGHT-OF-WAY LINE DOUBLES AS NORTH AND EAST PROPERTY LINE


# EASEMENT LIST

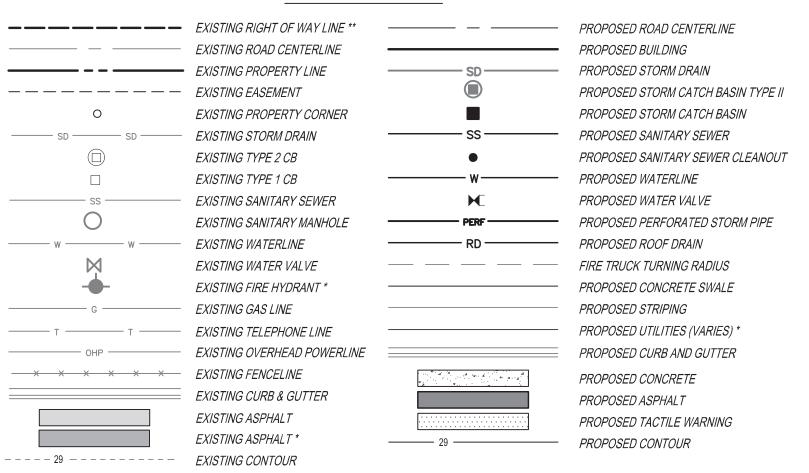
- 40' INGRESS AND EGRESS EASEMENT BENEFITING SMVBP LOT 3 AND LOT 4, 20' ON EACH SIDE OF THE NORTH-SOUTH PROPERTY LINE AND EXTENDING FROM THE NORTH TO THE SOUTH PROPERTY LINE. RECORDED UNDER AF NO. 202110010037
- B 26'X44' STORMWATER EASEMENT IN FAVOR OF SMVBP LOT 3. RECORDED UNDER AF NO. 202110010037
- C SHARED ACCESS & UTILITY EASEMENT FOR SMVBP LOTS 3&4, AF NO. 200709100133, AS AMENDED BY AF NO. 202111180016
- D 20' UTILITY & PUD EASEMENT TO BENEFIT SMVBP LOTS 1 THRU 8 INCLUSIVE, AF NO. 200709100133.
- E 10' UTILITY AND SIDEWALK EASEMENT, AF NO. 20070100133.
- 20' UTILITY EASEMENT, EXTENDING 20' EAST OF THE WEST PROPERTY LINE, PARTIALLY COVERING THE SAME AREA AS THE 40' INGRESS AND EGRESS EASEMENT (SEE EASEMENT A); TO BE CREATED WITH SMVBP LOT 4 SHORT PLAT (CMV FILE NUMBER PLAN21-0685)
- G 50'X153' WITH 15'X43' WING STORMWATER EASEMENT FOR TRENCH BED MAINTENANCE AND CONNECTION BETWEEN STREET STORM SYSTEM AND ON-SITE RAIN GARDEN; TO BE CREATED WITH SMVBP LOT 4 SHORT PLAT (CMV FILE NUMBER PLAN21-0685)
- H 24'X177.5' INGRESS AND EGRESS EASEMENT; TO BE CREATED WITH SMVBP LOT 4 SHORT PLAT (CMV FILE NUMBER PLAN21-0685)

# RECORDED DOCUMENTS

- 1. AFN 200709100133 SOUTH MOUNT VERNON BUSINESS PARK BINDING SITE PLAN
- 2. AFN 202110010037 ROAD EASEMENT AND MAINTENANCE AGREEMENT
- 3. AFN 202111180016 AMENDMENT TO EASEMENT

# EXISTING CONDITIONS

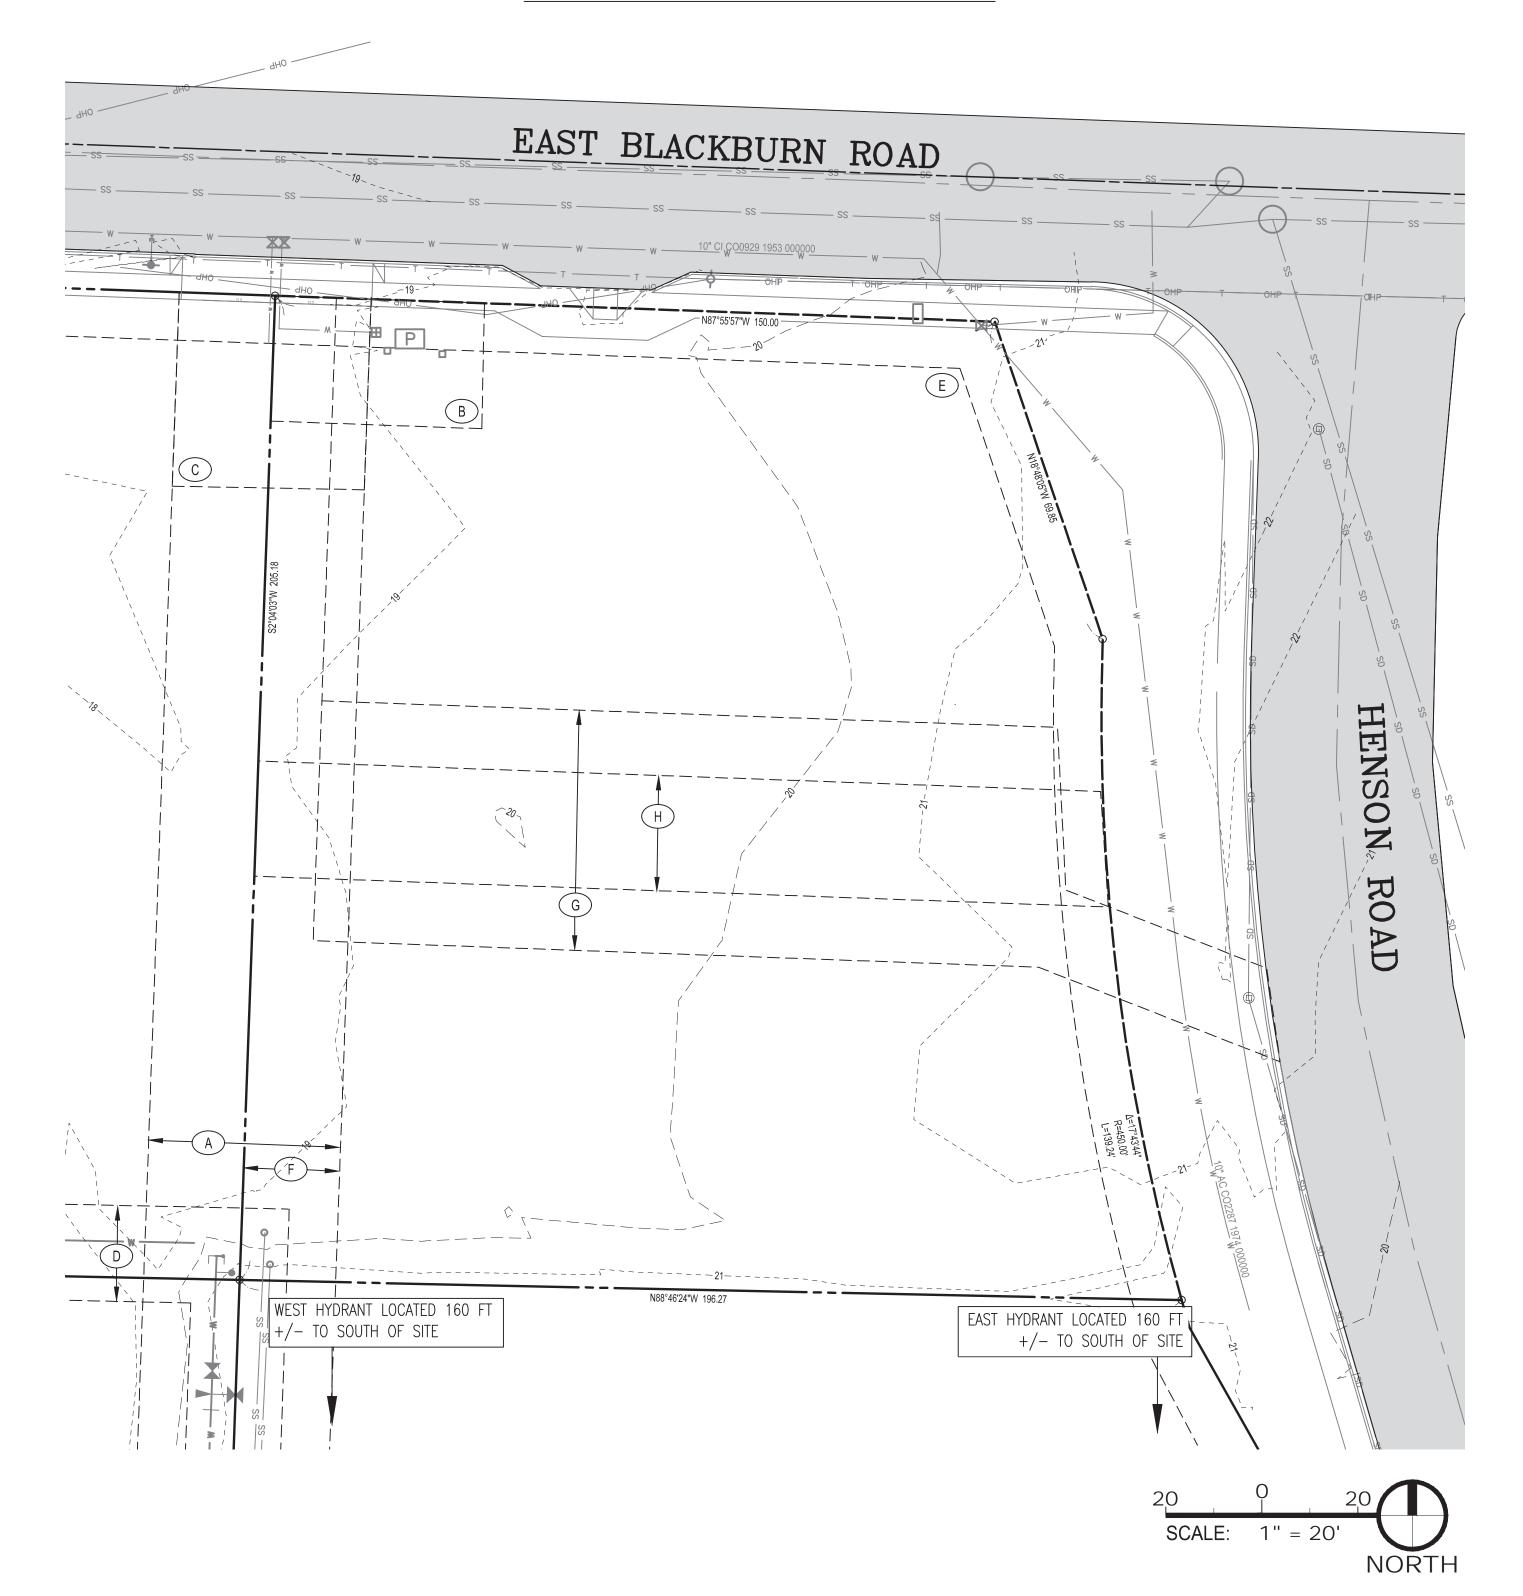

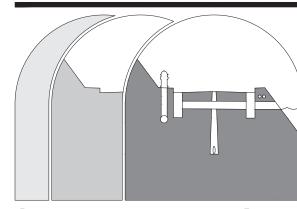

Sound Development Group
ENGINEERING, SURVEYING & LAND DEVELOPMENT SERVICES
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Mount Vernon, WA 98273 Tel: 360-404-2010

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2 6.20.24 SITE PLAN REVISION P.SEVERIN

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LOT 4 SMVBP
SITE PLAN
FOR

STING CONDITION MAP



SCALE:	1" = 20'
DRAWN BY:	C.SEVERIN
DESIGNED BY:	P.SEVERIN
DATE:	12.22.2021
JOB NUMBER:	21028
DWG NAME:	21028ENG.DWG

C-1.1

SHEET NUMBER:

## SITE PLAN NOTES

- BUILDING A EXTERIOR DIMENSIONS: 50.3' X 125.3'
  BUILDING B EXTERIOR DIMENSIONS: 47' X 143' WITH 2' X 22.75' JOGS TO THE SOUTH
- BUILDING A (MULTI-TENANT): WAREHOUSE/STORAGE = SEE ARCH. PLANS FOR AREA (FIVE, TWO-STORY UNITS)
  BUILDING B (MULTI-TENANT): WAREHOUSE/STORAGE = SEE ARCH. PLANS FOR AREA (SIX, TWO-STORY UNITS)
- (2) ALL SIDEWALKS ON SITE PERIMETER TO MAINTAIN 5.5' WIDTH WITH STREETSIDE CURB. SIDEWALKS IN SITE INTERIOR TO MAINTAIN AT LEAST 6' WIDTH AND ARE FLUSH WITH THE ASPHALT PARKING LOT.
- (3) ON-SITE PARKING STALLS TO BE STRIPED AT O' ANGLE WITH MINIMUM WIDTH OF 8.5' AND LENGTH OF 17' WITH A 2' OVERHANG INTO THE 6' SIDEWALK. LARGEST STALL ON SITE MEASURES 12' X 17', SMALLEST STALL ON—SITE MEASURES 8.5' X 17'. THERE ARE 2 HANDICAP STALLS PRESENT AND THREE COMPACT STALLS (WIDTH = 8.5'), AS DENOTED WITH A "C".
- (4) PARKING AREA LANDSCAPE ISLANDS MEASURE 6' X 16'
- DUMPSTER AND RECYCLING AREA: ONE STEP DOWN FROM SIDEWALK TO DUMPSTER AREA. EASTERN EDGE OF DUMPSTER PAD TO BE THICKENED EDGE CONCRETE THAT EXTENDS 1' DEEPER THAN THE BOTTOM OF THE ADJACENT BIORETENTION CELL, ADJACENT CATCH BASIN GRATE TO BE OFFSET WITH RISERS AS NECESSARY. DIMENSIONS: 12' X 15' PAD WITH 7' SCREENING AROUND DUMPSTER AREA
- (6) RIGHT OF WAY LINE AS DISPLAYED IS ALSO SOUTH MOUNT VERNON BUSINESS PARK LOT 4 NORTH AND EAST PROPERTY LINE
- 7 ON-SITE FIRE LANES, AS INDICATED WITH STRIPING ON THESE PLANS, ARE TO BE IN ACCORDANCE WITH MOUNT VERNON MUNICIPAL CODE 15.08.130 AND INTERNATIONAL FIRE CODE APPENDIX D
- 8 ADA ACCESSIBLE RAMPS WITH TACTILE WARNING
- (9) ALL UTILITIES LOCATED WITHIN THE INGRESS/EGRESS EASEMENT (EASEMENT A) FOR LOT 3 WILL BE INSTALLED/STUBBED AT THE PROPERTY LINE BY LOT 4. LOT 3 WILL BE RESPONSIBLE FOR THE INSTALLATION OF THEIR UTILITIES WEST OF THE PROPERTY LINE AND THE PAVING OF THE SHARED ACCESS ROAD. THE FIRE HYDRANT IN THE NE CORNER OF LOT 3 WILL BE INSTALLED BY PUD. LOT 4 WILL BE RESPONSIBLE FOR ALL UTILITIES BENEFITING LOT 4, INCLUDING FIRE DEPARTMENT CONNECTIONS, SPRINKLER AND FDC LINES, AND SEWER LINES AS INDICATED. THE RAIN GARDEN IN THE NW CORNER OF LOT 4 WILL ALSO BE COMPLETED DURING THE DEVELOPMENT OF LOT 3, AS INDICATED
- NOTE: EASEMENT LIST FOR ITEMS A-H CAN BE FOUND ON PAGE C-1.1 OF THIS PLAN SET


## PROPOSED PARKING

PARKING STALL SIZE: WIDTH VARIES (MIN. 8.5', MAX. 12') BY 17' LONG # OF HANDICAP STALLS: 2

SITE PARKING						
BUILDING	TYPE OF USE FROM MVMC 17.84.030	PARKING RATIO REQUIRED	SQUARE FOOTAGE / # OF EMPLOYEES	# OF STALLS REQUIRED	# OF STALLS PROVIDED	
А	WAREHOUSE	1.5 EMPLOYEES PER STALL	5 EMPLOYEES	4	10	
В	WAREHOUSE	1.5 EMPLOYEES PER STALL	6 EMPLOYEES	4	14	

## REVISION 2 NOTE:

- THE FOLLOWING SITE PLAN FEATURES HAVE CHANGED FROM THE ORIGINALLY APPROVED PLAN SET:
- BUILDING A IS A STEEL BUILDING, CHANGED FROM WOOD-FRAMED EXTERIOR DIMENSIONS INCREASED BY 1.3'
- BUILDING A JOGS ON THE NORTH FACE HAVE BEEN REMOVED INCREASES SQUARE FOOTAGE OF BUILDING
- ALL SITE FEATURES HAVE BEEN SHIFTED SOUTH 3.8' TO REMAIN WITHIN BUILDING SETBACK LINES
- DUMPSTER PAD DIMENSIONS INCREASED TO ACCOMMODATE DUMPSTER SIZE ONE PARKING STALL FOR BUILDING A WAS REMOVED, BIORETENTION CELL ASSOCIATED WITH CB #2 INCREASED IN SIZE, CATCH BASIN #2 WILL NEED TO BE OFFSET AS NEEDED WITH RISERS, EASTERN EDGE OF PAD WILL BE THICKENED AND EXTEND 1' DEEPER THAN THE BOTTOM ELEVATION OF ADJACENT BIORETENTION CELL
- GRADING ASSOCIATED WITH PARKING LOT CONNECTIONS REVISED TO ACCOUNT FOR SOUTHERN SHIFT IN SITE AT CONNECTION WITH HENSON ROAD AND THE PLANNED ACCESS ROAD

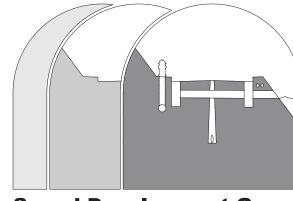

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DESIGNED BY:	P.SEVERIN
DATE:	12.22.2021
JOB NUMBER:	21028
DWG NAME:	21028ENG.DWG
SHEET NUMBER:	

C-1.2

BUILDING PLAN	UTILITY PLAN
20 0 20 SCALE: 1" = 20' NORTH	20 0 20 SCALE: 1" = 20' NORTH
EAST BLACKBURN ROAD  SS	EAST BLACKBURN ROAD  SS
W W W W W W W W W W W W W W W W W W W	W W W W W W W W W W W W W W W W W W W
RAIN CARDEN INSTALLED DURING LOT 3 DEVELOPMENT PROPOSED 25' BUILDING SETBACK LINE	PROPOSED 25' BUILDING SETBACK LINE
(REVISED LOCATION)  5' BUILDING SETBACK LINE WITH APPROVED  FINISHED FLOOR = 21 00'	(REVISED LOCATION)  SETBACK LINE WITH APPROVED  (REVISED LOCATION)  CONDOMINIUM WAREHOUSE BUILDING 'A'  FINISHED FLOOR = 21 00'
WITH APPROVED VARIANCE  FINISHED FLOOR = 21.00' (SEE ARCH. PLANS)  SPRINKLER ROOM  RECHANICAL/ SPRINKLER ROOM	WITH APPROVED VARIANCE  WITH APPROVED VARIANCE  WECHANICAL/ SPRINKLER ROOM  FINISHED FLOOR = 21.00' (SEE ARCH. PLANS)
R28.0 R28.0' R28.0' R28.0' R48.0' R28.0' R48.0' R48.0' R48.0' R48.0' R48.0' R48.0' R48.0' R48.0'	9 SS PERF PERF PERF PERF
HENSON  CONCRETE SWALE	
ROAD O O O REGISTRE R	B PERF PERF PERF PERF
PROPOSED 10' BUILDING SETBACK LINE  RAB.0'  A A A A A A A A A A A A A A A A A A A	PROPOSED 10' BUILDING  MECHANICAL/ SPRINKLER ROOM
1 CONDOMINIUM WAREHOUSE BUILDING 'B' FINISHED FLOOR = 21.00' (SEE ARCH. PLANS)	CONDOMINIUM WAREHOUSE BUILDING 'B' FINISHED FLOOR = 21.00' (SEE ARCH. PLANS)
	SCA DRA
N88°46′24″W 196.27  PROPOSED 10′ BUILDING SETBACK LINE	N88°46′24″W 196.27  WEST HYDRANT LOCATED 160 FT +/- TO SOUTH OF SITE  PROPOSED 10' BUILDING SETBACK LINE  TO SOUTH OF SITE  DAT  JOB  DWG  SHE  SHE  DAT  JOB  DWG  SHE  SHE  DES  DAT  DAT  SETBACK LINE  PROPOSED 10' BUILDING SETBACK LINE  SETBACK LINE  DAT  JOB  DWG  SHE
	SHE